

SITE DATA TABLE: 604,606,608, & 610 CASTLE ST. & 609 S. 7th ST. R05409-011-029-000, 027-000, 003-000 TOTAL PROJECT AREA 23,483 SF (0.54 AC.) **EXISTING ZONING** CAMA LAND CLASSIFICATION URBAN MIXED USE (RETAIL/APARTMENTS) NUMBER OF BUILDINGS 1 (3-Story) **BUILDING HEIGHT** BUILDING AREA (GROSS SF)

1,707 SF 10,108 SF 1ST FLOOR 3,686 SF 2ND FLOOR 3,736 SF 3RD FLOOR 2,686 SF

7.27% PROPOSED 43.04%

**PROVIDED** FRONT - 0'

\* WHEN ABUTTING RESIDENTIAL

**EXISTING IMPERVIOUS AREAS** EXISTING BUILDINGS EXISTING ASPHALT PARKING 4,566 SF EXISTING GRASS PARKING 4,055 SF EXISTING CONCRETE AREA 280 SF 10,609 SF(45.18%)

PROPOSED IMPERVIOUS AREA BUILDING (PROPOSED) 4,145 SF PROPOSEĎ PARKING

4,121 SF (11,621 TOTAL \* SEE NOTE BELOW) 1,574 SF 9,840 SF (41.90%)

\*10,000SF OF PARKING AREA TO BE PERVIOUS PAVEMENT AT 75% CREDIT 0.64 Ac.

LIMITS OF DISTURBANCE:

## OFF-STREET PARKING REQUIREMENTS

PROVIDED 13 Spaces RETAIL USAGE (1 UNIT @ 1.000 SF)

10 Spaces 11 Spaces \* PARKING AMOUNTS ALLOWED WITH USE OF ONE LOT CONSIDERED A COMMERCIAL

**CURRENT** PROPOSED 171 GPD 2,400 GPD (20BR @ 120 GPD/BR) 188 GPD 3,000 GPD ( 20BR @ 150 GPD/BR)

1. ALL DEVELOPMENT SHALL BE IN ACCORDANCE WITH THE CITY OF WILMINGTON LAND DEVELOPMENT CODE.

2. PROJECT SHALL COMPLY WITH ALL FEDERAL, STATE & NEW HANOVER COUNTY REGULATIONS.

3. PROPERTY IS LOCATED IN ZONE "X" ACCORDING TO THE FEMA FLOOD INSURANCE RATE MAP, COMMUNITY-PANEL NUMBER 3720312700 J, DATED 04/03/06 4. TOPO SHOWN PROVIDED BY "NAVD 88" BENCH MARK

## UTILITY NOTES:

1. EXISTING WATER AND SANITARY SEWER SERVICES ARE CURRENTLY AVAILABLE TO THE SITE FROM CAPE FEAR PUBLIC UTILITY AUTHORITY PUBLIC MAINS. 2. ALL UTILITY SERVICES, SUCH AS ELECTRIC POWER, CATV, GAS & TELEPHONE SHALL BE INSTALLED UNDERGROUND.

3. ALL WATER & SEWER UTILITIES TO BE INSTALLED PER CFPUA TECHNICAL

SPECIFICATIONS & STANDARDS.

4. PROJECT SHALL COMPLY WITH CFPUA CROSS CONNECTION CONTROL REQUIREMENTS. WATER METER(S) CANNOT BE RELEASED UNTIL ALL REQUIREMENTS ARE MET AND N.C.D.E.N.R. HAS ISSUED THEIR "FINAL APPROVAL.". CALL 343-3910 FOR INFORMATION.

5. ANY BACKFLOW PREVENTION DEVICES REQUIRED BY THE CFPUA WILL NEED TO BE ON THE LIST OF APPROVED DEVICES BY USCFCCCHR OR ASSE.

6. WATER & SEWER SERVICES CAN NOT BE ACTIVATED ON NEW MAINS UNTIL THE ENGINEER'S CERTIFICATION AND AS-BUILTS ARE RECEIVED AND "FINAL APPROVAL" ISSUED BY THE PUBLIC WATER SUPPLY SECTION OF NCDENR, AND "FINAL

7. IF CONTRACTOR DESIRES CFPUA WATER FOR CONSTRUCTION, HE SHALL APPLY IN ADVANCE FOR THIS SERVICE AND MUST PROVIDE A REDUCED PRESSURE ZONE (RPZ)

8. WHEN PVC WATER MAINS AND SERVICES ARE PROPOSED, THE PIPES ARE TO BE MARKED WITH NO. 10 INSULATED, SINGLE-STRAND COPPER WIRE INSTALLED & STRAPPED TO THE PIPES WITH DUCT TAPE. THIS IS TO BE ACCESSIBLE IN ALL VALVES

AND METER BOXES TO AID IN FUTURE LOCATION OF FACILITIES 9. THE CONTRACTOR IS RESPONSIBLE FOR THE LOCATION AND PROTECTION OR EXISTING UTILITIES DURING CONSTRUCTION. CALL U-LOCO AT 1-800-632-4949. CONTRACTOR IS RESPONSIBLE FOR THE REPAIR AND REPLACEMENT OF ANY UTILITIES, CURB & GUTTER, PAVEMENT, ETC. THAT MAY BE BE DAMAGED DURING CONSTRUCTION. DAMAGED ITEMS SHALL BE REPAIRED TO AT LEAST THE QUALITY OR WORKMANSHIP FOUND IN THE ORIGINAL ITEM.

10. THE BELLSOUTH CONTACT IS STEVE DAYVAULT, BUILDING INDUSTRY CONSULTANT, AT 910-392-8712. CONTACT HIM PRIOR TO STARTING THE PROJECT IN ORDER TO FACILITATE GOOD COMMUNICATION AND MAXIMUM FLEXIBILITY.

1. THE PROCESS FOR TELEPHONE CABLE PLACEMENT: \* FINAL GRADE WILL NEED TO BE ESTABLISHED. \* POWER WILL PLACE THEIR CABLE FIRST - APPROXIMATELY 3' DEEP. \* BELLSOUTH & CABLE TV WILL THEN PLACE THEIR CABLE AT APPROXIMATELY 2'

12. SOLID WASTE DISPOSAL IS TO BE ROLL OUT CONTAINERS.

# TRAFFIC NOTES:

1. ALL PAVEMENT MARKINGS IN PUBLIC RIGHTS-OF-WAY & FOR DRIVEWAY ARE TO BE THERMOPLASTIC & MEET CITY AND/OR NCDOT STANDARDS.

OPEN TO PUBLIC TRAFFIC ARE TO MEET MUTCD (MANUAL ON UNIFORM TRAFFIC CONTROL DEVICES) STANDARDS. 3. CONTACT TRAFFIC ENGINEERING, AT 341-7888 TO ENSURE THAT ALL TRAFFIC SIGNAL FACILITIIES AND EQUIPMENT ARE SHOWN ON THE PLAN. ADD A NOTE TO CALL

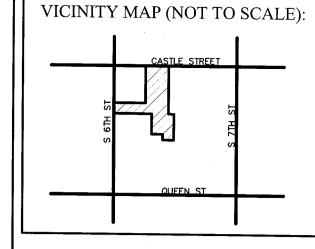
TRAFFIC ENGINEERING A MIN. OF FORTY-EIGHT (48) HOURS PRIOR TO ANY EXCAVATION IN THE R/W.

4. ANY BROKEN OR MISSING SIDEWALK PANELS, DRIVEWAY PANELS AND CURBING WILL BE REPLACED.

5. CONTACT KAREN DIXON AT 341-7888 TO DISCUSS STREET LIGHTING OPTIONS. THE LANDSCAPING PLAN WILL BE NEEDED TO DETERMINING STREET LIGHT LOCATIONS. 6. TACTILE WARNING MATS TO BE INSTALLED AT ALL WHEELCHAIR RAMPS.

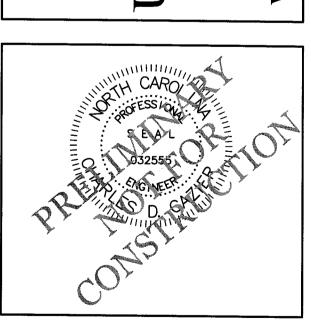
7. A LANDSCAPING PLAN, INDICATING THE LOCATION OF REQUIRED STREET TREES SHALL BE SUBMITTED TO THE TRAFFIC ENGINEERING DIVISION AND PARKS & RECREATION DEPARTMENT FOR REVIEW AND APPROVAL PRIOR TO THE RECORDING OF THE FINAL PLAT. PLAN SHALL ADHERE TO SD 15-17.

STORMWATER MANAGEMENT PLAN Approved Construction Plan **APPROVED** <u>Date</u> CITY OF WILMINGTON ENGINEERING DEPARTMENT SIGNED



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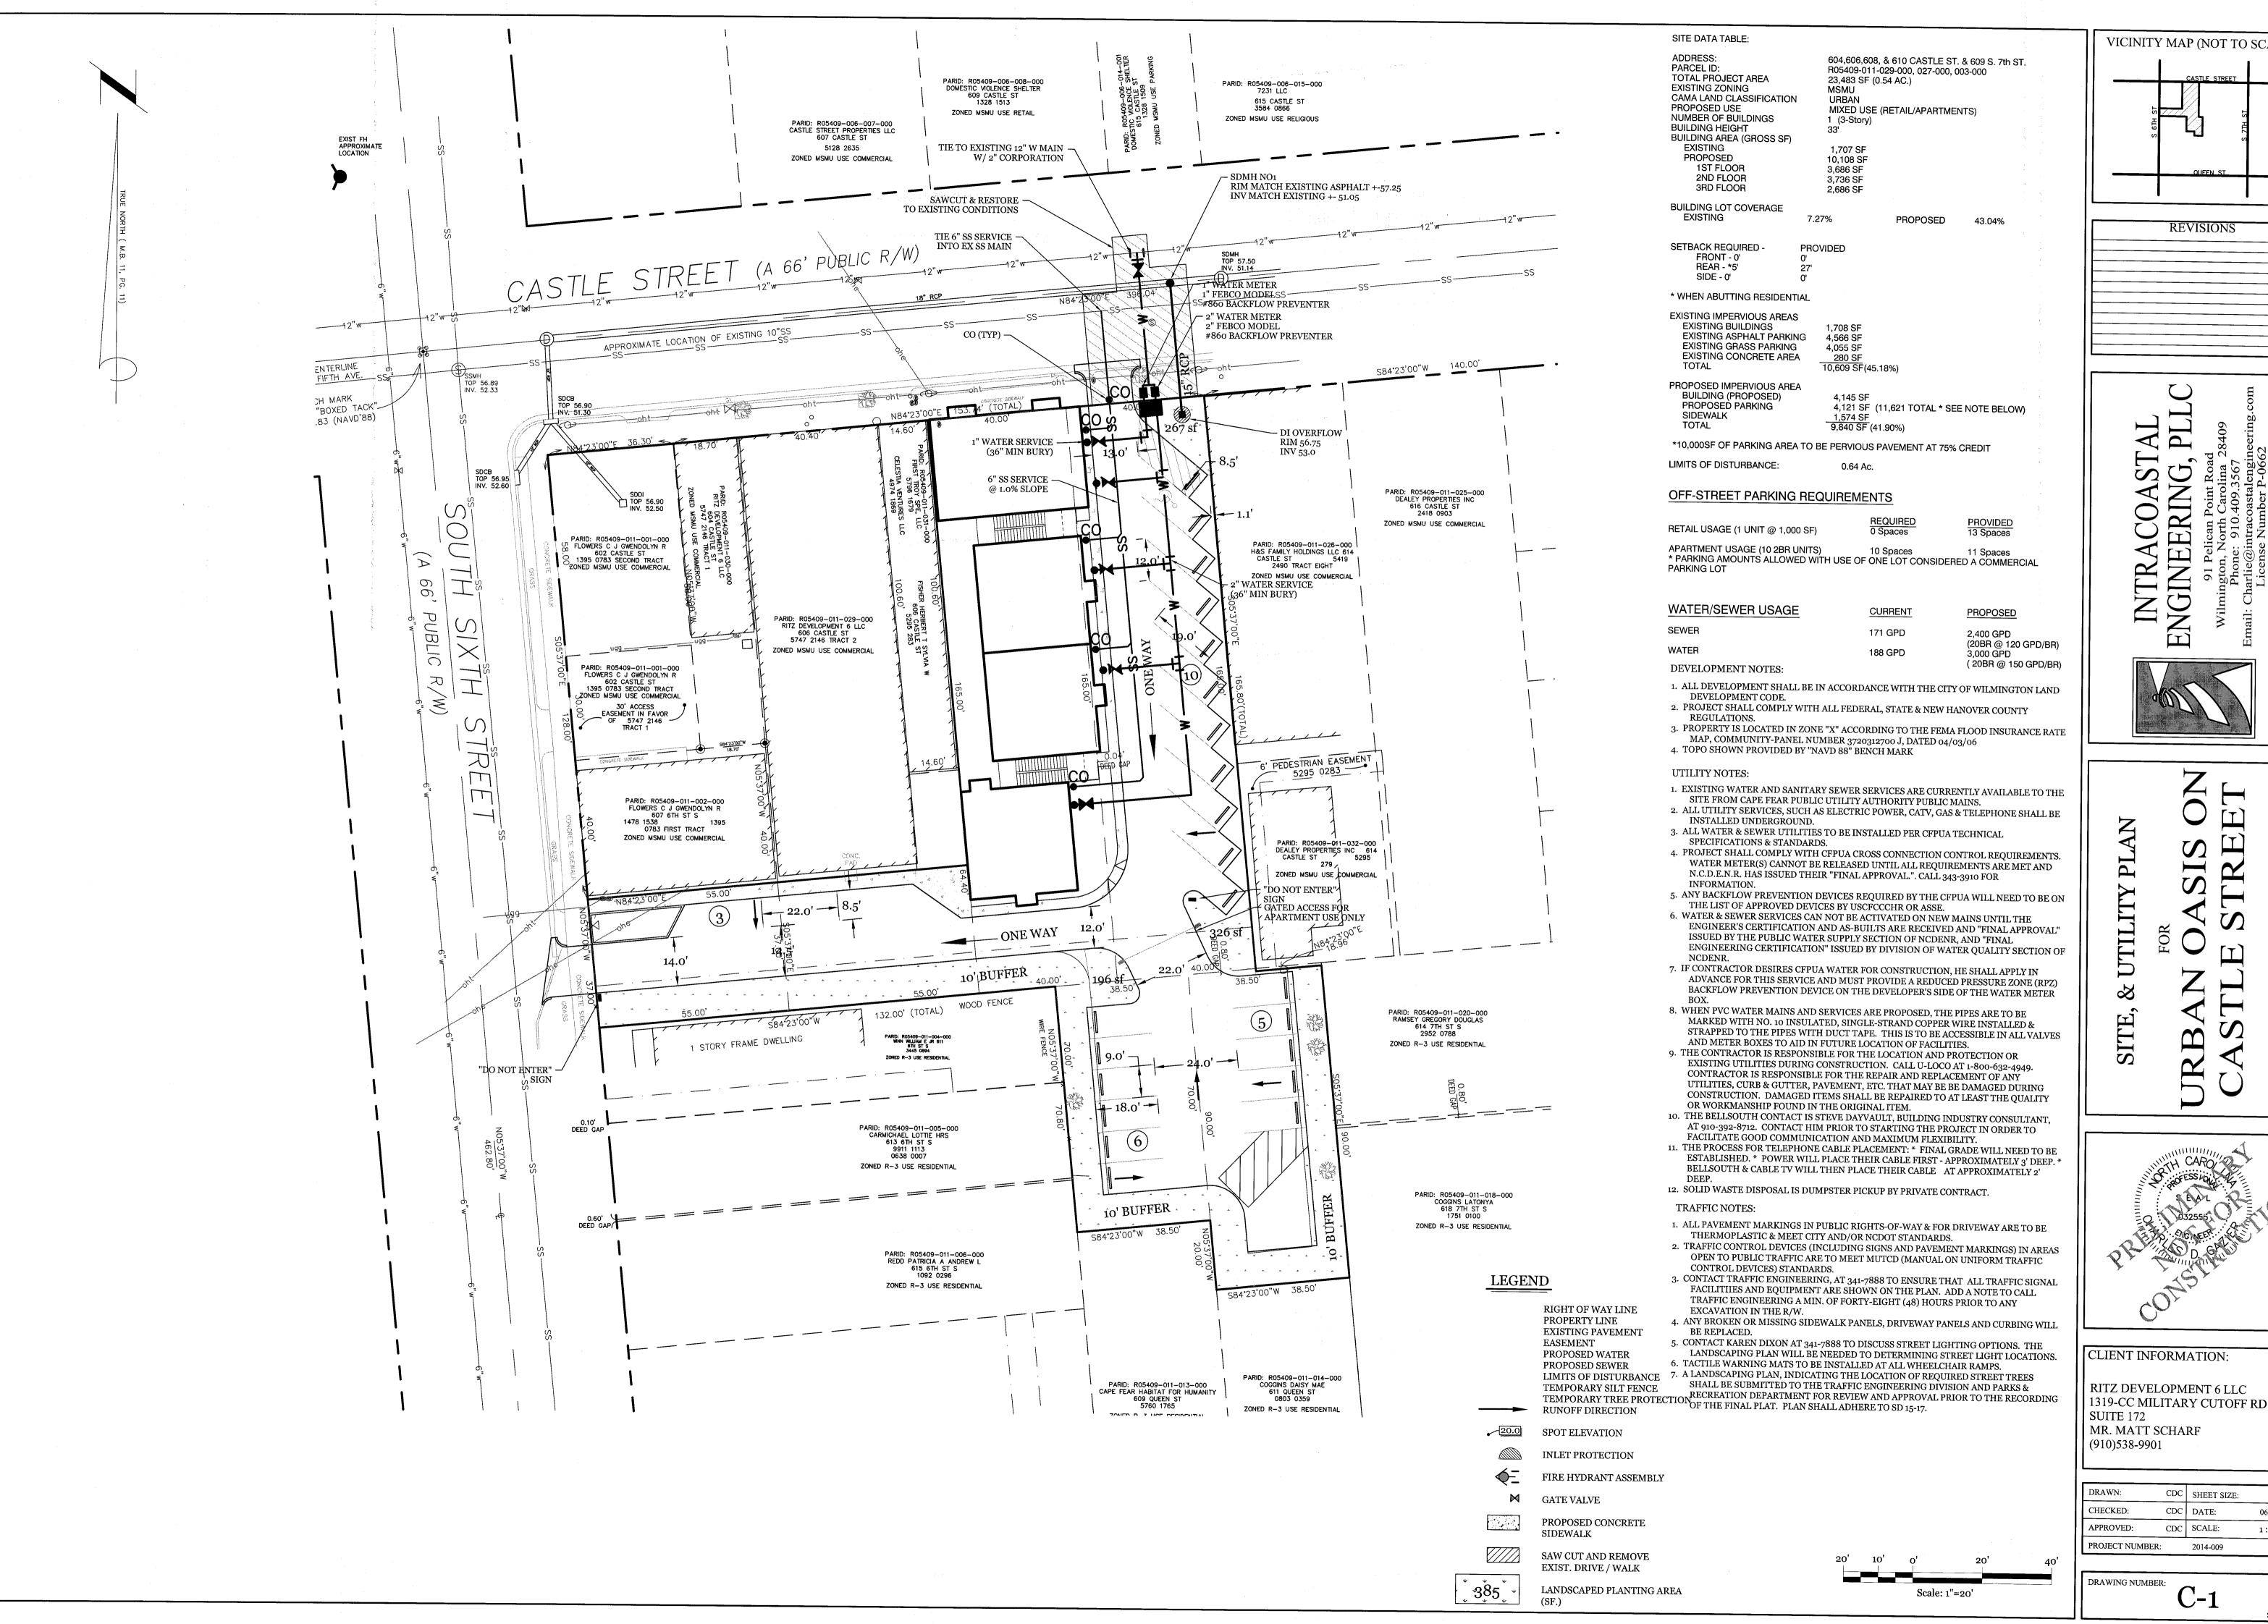


CLIENT INFORMATION:

RITZ DEVELOPMENT 6 LLC 1319-CC MILITARY CUTOFF RD SUITE 172 MR. MATT SCHARF (910)538-9901

PROJECT NUMBER:		2014-009	
APPROVED:	CDC	SCALE:	1:20
CHECKED:	CDC	DATE:	06/04/2014
DRAWN:	CDC	SHEET SIZE:	24 x 36

DRAWING NUMBER: C-o



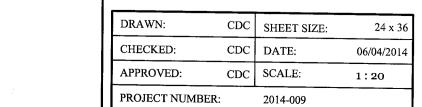
VICINITY MAP (NOT TO SCALE):

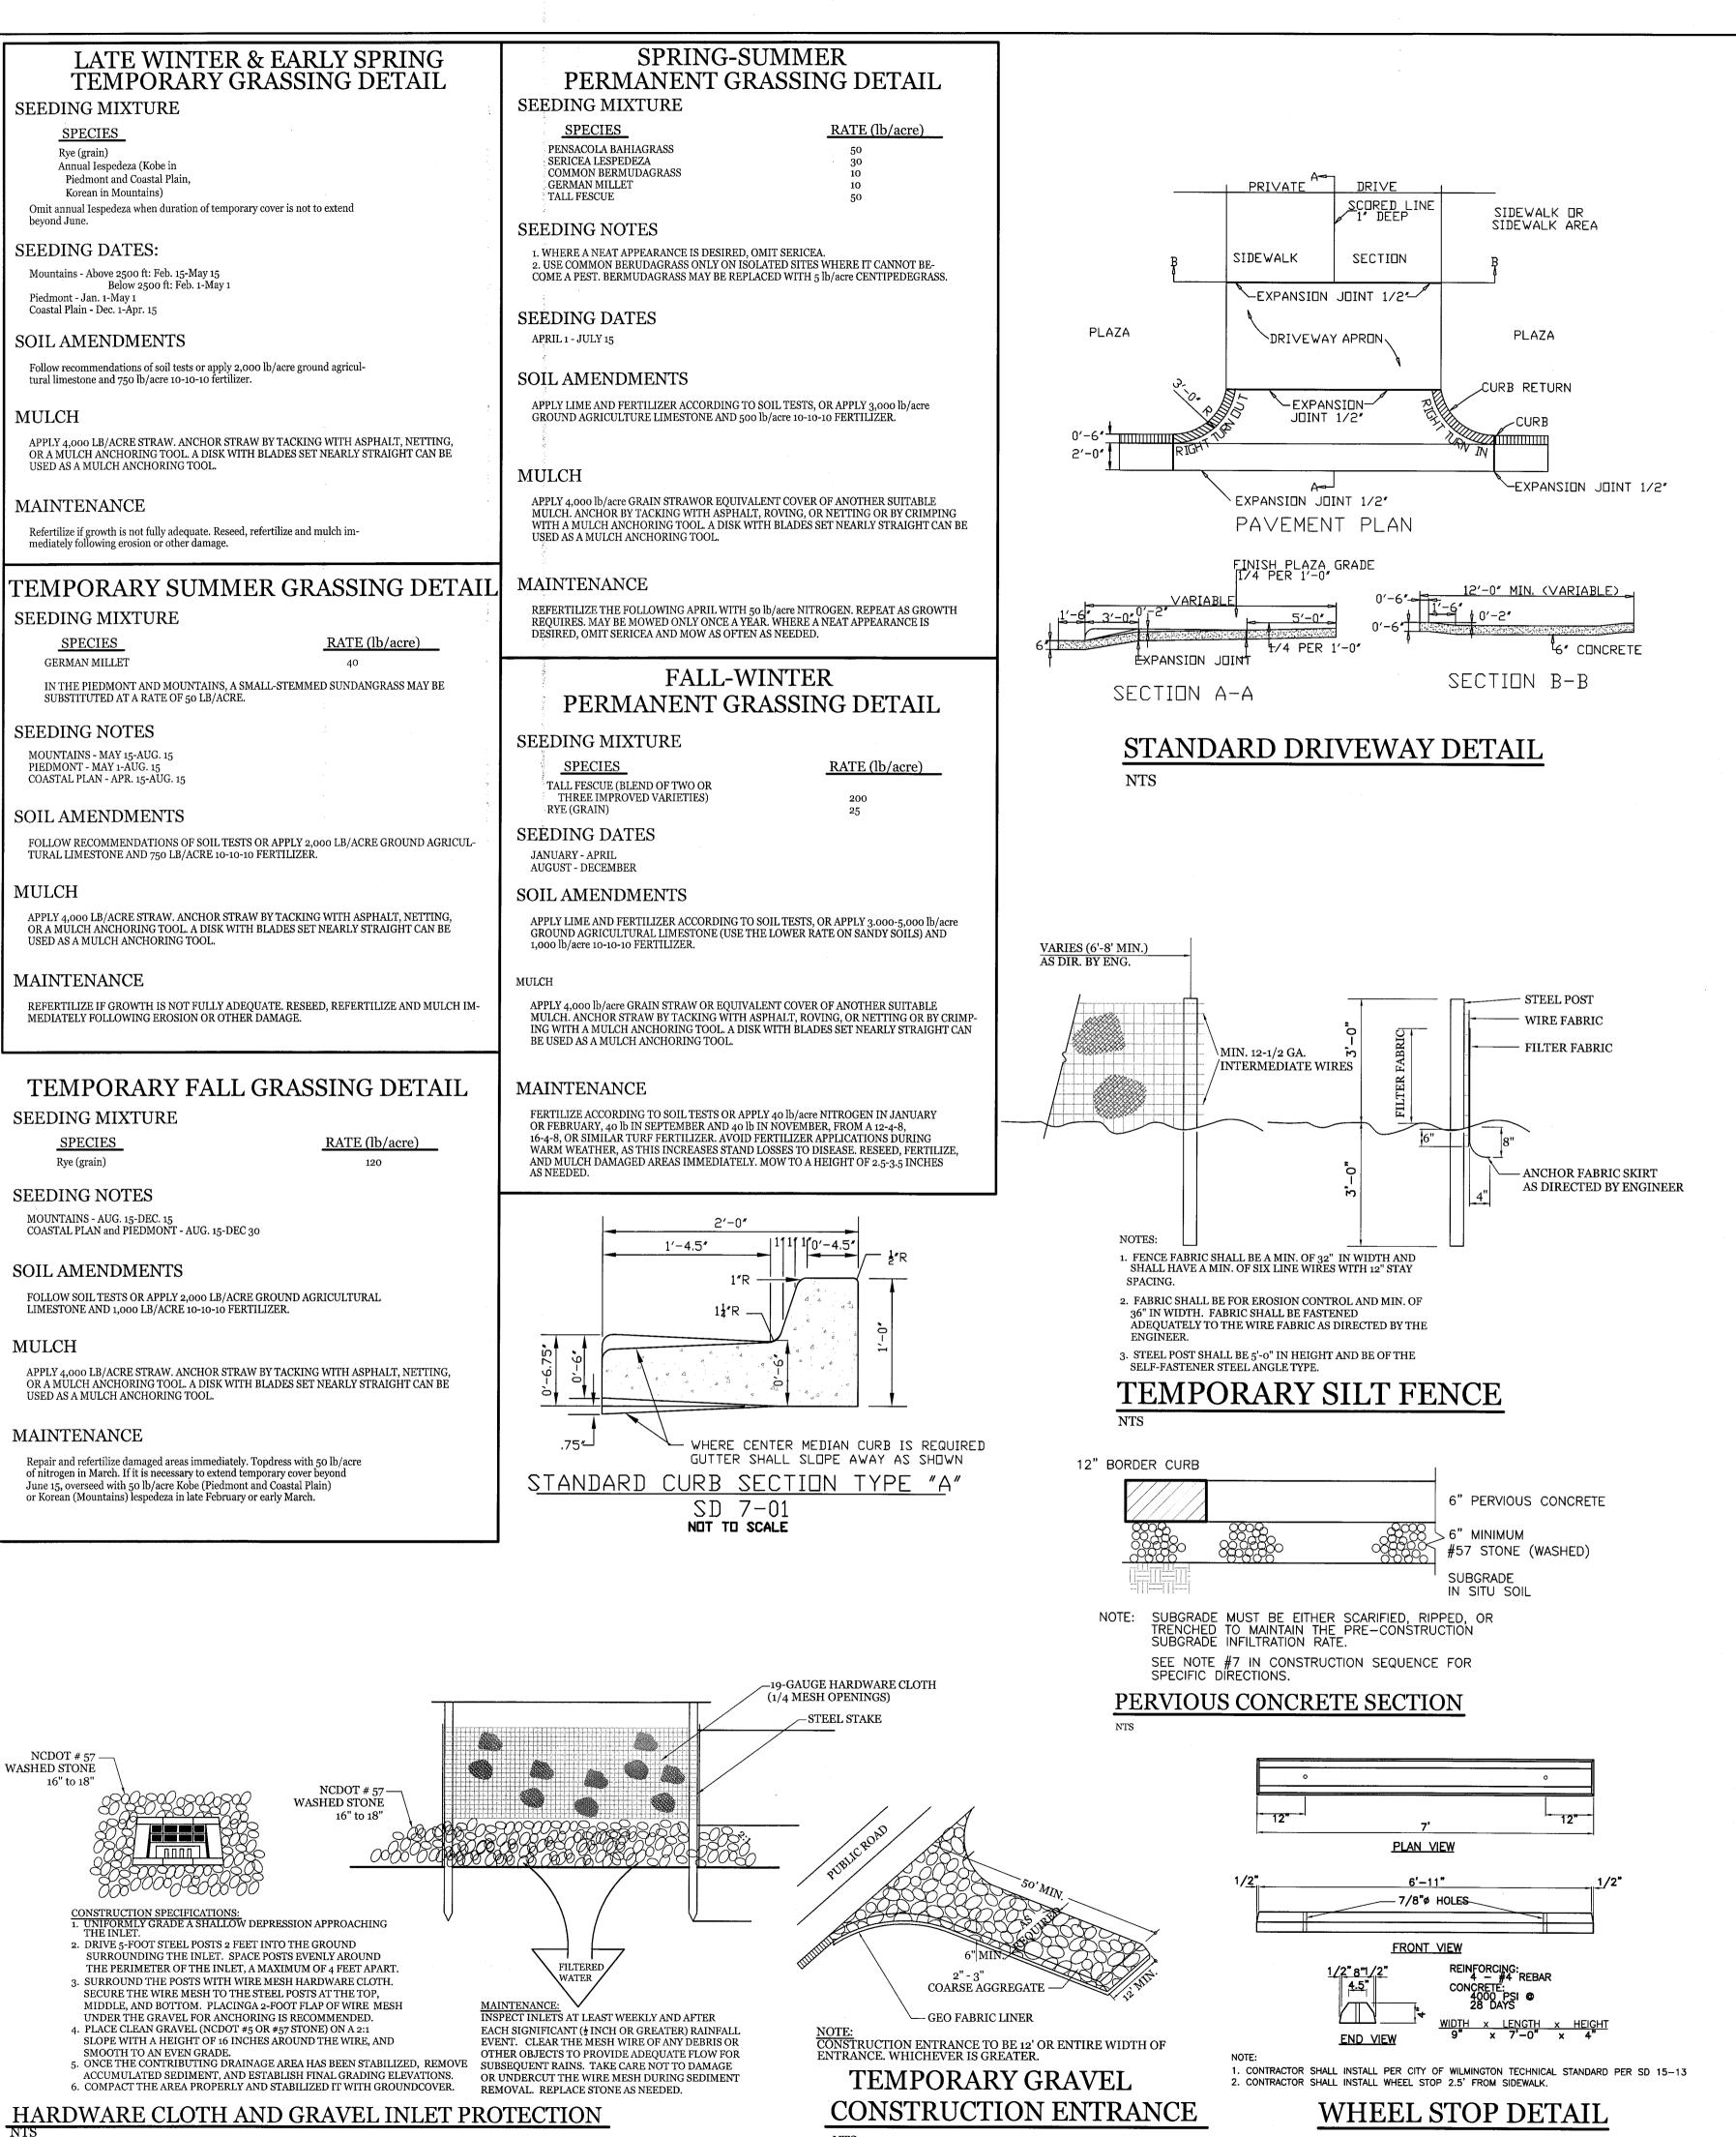
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SITE WORK NOTES:

- THE CONTRACTOR SHALL VISIT THE SITE AND BECOME FAMILIAR WITH EXISTING CONDITIONS BOTH ON AND ADJACENT TO THE SITE.
- CLEARING: CONTRACTOR SHALL REMOVE ALL TREES AND VEGETATION WITHIN LIMITS OF CONSTRUCTION IF DESIGNATED TO BE REMOVED 3. GRUBBING AND STRIPPING: CONTRACTOR SHALL RAKE AND REMOVE ROOTS, STUMPS, VEGETATION, DEBRIS, EXISTING STRUCTURES ABOVE AND BELOW GRADE, ORGANIC
- MATERIAL OR ANY OTHER UNSUITABLE MATERIAL WITHIN LIMITS OF CONSTRUCTION. MUCKING: CONTRACTOR SHALL COORDINATE WITH OWNER AND THEIR GEOTECHNICAL REPRESENTATIVE TO COORDINATE REMOVAL OF ANY SOFT AREAS.
- DISPOSAL: CLEARED, GRUBBED, STRIPPED OR OTHER WASTE MATERIAL SHALL BE REMOVED FROM SITE AND DISPOSED OF IN A PROPERLY PERMITTED FACILITY.
- FILL AND COMPACTION SHOULD COMPLY WITH GEOTECHNICAL RECOMMENDATIONS. 7. THE CONTRACTOR SHALL NOTE THAT THE GRADING PLAN MAY NOT REPRESENT A BALANCED EARTHWORK CONDITION. THE CONTRACTOR SHALL BE RESPONSIBLE FOR
- CUT AND FILL QUANTITIES AND COMPLETE INSTALLATION TO SPECIFIED GRADES. 8. THE CONTRACTOR SHALL FURNISH SUITABLE BORROW MATERIAL FROM AN OFF-SITE PROPERLY PERMITTED FACILITY AS REQUIRED
- 9. INFORMATION CONCERNING UNDERGROUND UTILITIES WAS OBTAINED FROM AVAILABLE RECORDS. IT SHALL BE THE RESPONSIBILITY OF THE CONTRACTOR TO DETERMINE THE EXACT ELEVATIONS AND LOCATIONS OF ALL EXISTING UTILITIES AT ALL CROSSINGS PRIOR TO COMMENCING TRENCH EXCAVATION. IF ACTUAL CLEARANCES ARE LESS THAN INDICATED ON PLAN, THE CONTRACTOR SHALL CONTACT THE DESIGN ENGINEER BEFORE PROCEEDING WITH CONSTRUCTION, ANY CONDITION DISCOVERED OR EXISTING THAT WOULD NECESSITATE A MODIFICATION OF THESE PLANS SHALL BE BROUGHT TO THE ATTENTION OF THE DESIGN ENGINEER BEFORE PROCEEDING WITH CONSTRUCTION.
- 10. NO CONSTRUCTION IS TO BEGIN BEFORE LOCATION OF EXISTING UTILITIES HAS BEEN DETERMINED. CALL "NC ONE-CALL" AT LEAST 48 HOURS BEFORE COMMENCING CONSTRUCTION. 11. THE CONTRACTOR IS RESPONSIBLE FOR THE LOCATION AND PROTECTION OF ALL EXISTING UTILITIES DURING CONSTRUCTION. BEFORE COMMENCING ANY EXCAVATIONS
- IN OR ALONG ROADWAYS OR RIGHT-OF-WAYS. PUBLIC AREAS OR IN PRIVATE EASEMENTS, THE CONTRACTOR SHALL NOTIFY ALL APPROPRIATE PERSONNEL OF THEIR INTENT TO EXCAVATE. IN WRITING, NOT LESS THAN 10 DAYS PRIOR TO EXCAVATING. 12. THE CONTRACTOR SHALL BE RESPONSIBLE TO COORDINATE DISCONNECTION/ RECONNECTION AND/OR THE RELOCATION OF ALL EXISTING UTILITIES WITH APPROPRIATE
- 13. CONTRACTOR SHALL ADJUST ALL MANHOLES, VALVE & CURB BOXES TO FINAL GRADE UPON COMPLETION OF ALL CONSTRUCTION. ANY BOXES DAMAGED OR OTHERWISE
- DISTURBED BY THE CONTRACTOR SHALL BE REPAIRED AT THE EXPENSE OF THE CONTRACTOR. 14. EXISTING SURVEYING PERFORMED BY ARNOLD W. CARSON, PLS PC. PHONE: 910-772-9113.
- 15. THE CONTRACTOR SHALL FIELD VERIFY ALL DIMENSIONS AT THE SITE. FURTHERMORE THE CONTRACTOR SHALL REPORT ALL DISCREPANCIES OR QUESTIONS TO THE ENGINEER PRIOR TO INSTALLATION.
- 16. THE CONTRACTOR SHALL PROVIDE ANY AND ALL LAYOUT REQUIRED TO CONSTRUCT HIS WORK UNLESS OTHERWISE DIRECTED BY OWNER. 17. ALL SERVICE CONNECTIONS SHALL BE INSTALLED TO MEET ALL LOCAL, STATE, AND CFPUA CODES. METERS, TAPS, MATERIALS, WORKMANSHIP AND ALL FEES SHALL BE THE
- RESPONSIBILITY OF THE CONTRACTOR AND SHALL COMPLY WITH ALL REQUIREMENTS. 18. ALL BACKFILL FROM UTILITY INSTALLATION MUST BE COMPACTED OR AMENDED TO PROVIDE TRAFFIC BEARING CAPACITY. GEOTECHNICAL ENGINEER TO BE CONSULTED
- AT CONTRACTORS COST AS NECESSARY. 19. ALL AREAS SHALL BE GRADED FOR POSITIVE DRAINAGE. CONTRACTOR SHALL REPORT ANY DISCREPANCIES TO THE ENGINEER PRIOR TO INSTALLATION. ALL AREAS SHALL BE SLOPED TO DRAIN AWAY FROM BUILDINGS AT ALL TIMES.
- 20. CONCRETE FOR WALKS, CURBS AND DRIVES SHALL HAVE A MINIMUM COMPRESSIVE STRENGTH OF 3000 PSI @ 28 DAYS AIR ENTRAINED 21. FIELD TESTING SHALL BE DONE BY AN INDEPENDENT TESTING LABORATORY PAID FOR BY THE OWNER. FURTHER TESTING REQUIRED DUE TO A FAILED TEST WILL BE PAID
- FOR BY THE CONTRACTOR. 22. ALL SIDEWALKS SHALL BE FREE OF CRACKS, BREAKS, OR ANY OTHER DEFECT PRIOR TO RECEIVING A CERTIFICATE OF OCCUPANCY.

#### CONSTRUCTION SEQUENCE:

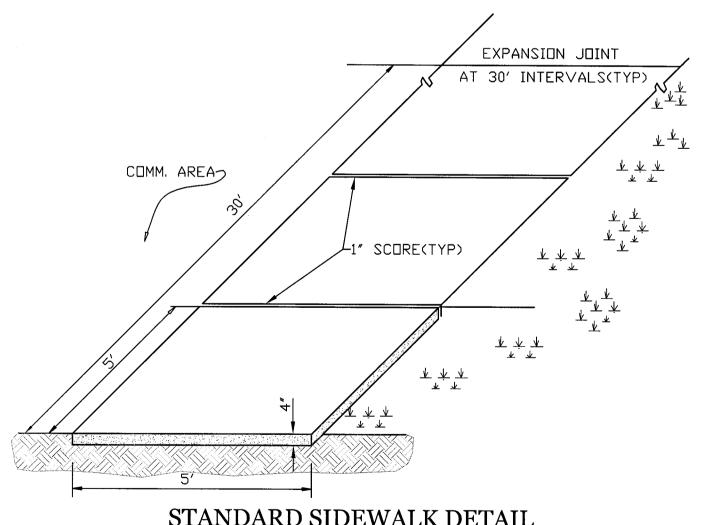
ENTRANCES HAVE BEEN INSTALLED.

CONSTRUCTION OF SITE TO START WITH INSTALLATION OF CONSTRUCTION ENTRANCE, SEDIMENT TRAP, TREE PROTECTION FENCE AND SILT FENCE ALONG ALL LOCATIONS PER PLANS. UPON INSTALLATION OF SILT FENCE, TREES SHOULD BE REMOVED IN LOCATIONS AS NECESSARY. ALL SLOPED AREAS SHOULD BE SEEDED IN ACCORDANCE TO SPECIFICATIONS. SLOPE STABILIZATION IS WITHIN 21 CALENDAR DAYS OF ANY PHASE OF CONSTRUCTION. ALL OTHER AREAS MUST BE STABILIZED WITHIN 15 WORKING DAYS. 1. GENERAL CLEARING AND GRADING OF THIS SITE WILL NOT BE DONE UNTIL THE TEMPORARY SILT FENCE, SEDIMENT TRAP, TREE PROTECTION FENCE, AND CONSTRUCTION

- 2. NO CUT SLOPE OR FILL SLOPE SHALL EXCEED A RISE OR FALL OF ONE FOOT FOR EVERY RUN OF 3 FEET (1 VERTICAL TO 3 HORIZONTAL)
- NO SEDIMENT WILL BE ALLOWED TO EXIT THE SITE. ALL EROSION SHALL BE CONTROLLED INCLUDING SIDE SLOPES DURING AND AFTER CONSTRUCTION. INSTALL PRIMARY EROSION CONTROL MEASURES BEFORE BEGINNING CONSTRUCTION INCLUDING BUT NOT LIMITED TO GRAVELED CONSTRUCTION ENTRANCE, SILT
- FENCE & CHECK DAMS. INSTALL ALL SECONDARY EROSION CONTROL MEASURES AS SOON AS POSSIBLE AFTER BEGINNING CONSTRUCTION. UTILITY SERVICES, STORMWATER, & INFILTRATION BASINS TO BE INSTALLED AT THIS TIME. CONCRETE BUILDING FOUNDATIONS AND SIDEWALKS TO BE POURED.
- CONTRACTOR TO COORDINATE CONSTRUCTION SEQUENCE WITH ENGINEER. CONTRACTOR TO FOLLOW
- BUILDING PADS TO BE BROUGHT TO GRADE AND POURED.
- PERVIOUS PAVEMENT SUBGRADE TO BE PREPARED AND PAVEMENT POURED.
- BUILDINGS TO BE ERECTED. CONTRACTOR TO PROTECT ALL PERVIOUS PAVEMENT FROM WOOD DEBRIS & SAWDUST. 7. CONTRACTOR TO FOLLOW CONSTRUCTION SPECIFICATIONS FOR POROUS CONCRETE PROVIDED BY THE ENGINEER & REQUIRED IN STORMWATER PERMIT. CONTRACTOR
- MUST CONTACT ENGINEER FOR SPECIFICATIONS PRIOR TO CONSTRUCTION TO PREVENT SUBGRADE COMPACTION AND CLOGGING OF THE PAVEMENT SURFACE AS WELL AS THE OTHER UNIOUE CONSTRUCTION CONSIDERATIONS FOR PERVIOUS CONCRETE.
- 8. ALL EROSION CONTROL MEASURES TO BE INSPECTED AFTER EACH RAIN. SILT FENCE TO BE CLEANED WHEN HALF FULL
- 9. A 4" LAYER OF TOPSOIL SHALL BE APPLIED TO ALL NEW AREAS TO BE GRASSED.
- 10. ALL DISTURBED AREAS SHALL BE SEEDED IN ACCORDANCE WITH SEEDING SCHEDULI 11. MAINTAIN ALL EROSION CONTROL MEASURES UNTIL PROJECT IS COMPLETE.
- 12. MORE STRINGENT MEASURES MAY BE REQUIRED TO HALT EROSION IF THOSE ON THIS PLAN PROVE TO BE LESS EFFECTIVE.
- 13. REMOVE ALL TEMPORARY EROSION CONTROL MEASURES UPON COMPLETION OF CONSTRUCTION. ALL PERMANENT MEASURES SHALL BE WELL ESTABLISHED PRIOR TO PROJECT COMPLETION.

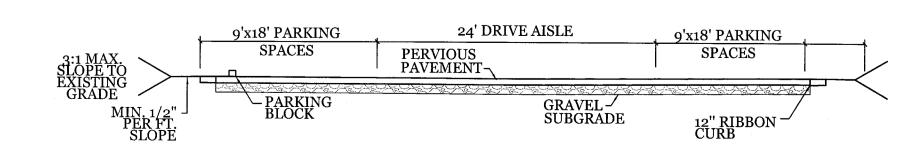
### MAINTENANCE PLAN

- 1. ALL EROSION AND SEDIMENT CONTROL PRACTICES WILL BE CHECKED FOR STABILITY AND OPERATION FOLLOWING EVERY RUNOFF-PRODUCING RAINFALL, BUT IN NO CASE, LESS THAN ONCE EVERY WEEK AND WITHIN 24 HOURS OF EVERY HALF INCH RAINFALL.
- 2. ALL POINTS OF EGRESS WILL HAVE CONSTRUCTION ENTRANCES THAT WILL BE PERIODICALLY TOP-DRESSED WITH AN ADDITIONAL 2 INCHES OF 2-3 INCH STONE TO MAINTAIN PROPER DEPTH. THEY WILL BE MAINTAINED IN A CONDITION TO PREVENT MUD OR SEDIMENT FROM LEAVING THE SITE. IMMEDIATELY REMOVE OBJECTIONABLE MATERIAL SPILLED, WASHED OR TRACKED ONTO THE CONSTRUCTION ENTRANCE OR ROADWAYS.
- SEDIMENT WILL BE REMOVED FROM HARDWARE CLOTH AND GRAVEL INLET PROTECTION, ROCK DOUGHNUT INLET PROTECTION, SEDIMENT TRAP BAFFLES, AND ROCK PIPE INLET PROTECTION WHEN THE DESIGNED STORAGE CAPACITY HAS BEEN HALF FILLED WITH SEDIMENT. ROCK WILL BE CLEANED OR REPLACED WHEN THE SEDIMENT POOL NO LONGER DRAINS AS DESIGNED. DEBRIS WILL BE REMOVED FROM THE ROCK AND HARDWARE CLOTH TO ALLOW PROPER DRAINAGE. SILT SACKS WILL BE EMPTIED ONCE A WEEK AND AFTER EVERY RAIN EVENT. SEDIMENT WILL BE REMOVED FROM AROUND BEAVER DAMS, DANDY SACKS AND SOCKS ONCE A WEEK AND AFTER EVERY RAIN EVENT.
- 4. CHECK SEDIMENT BASIN AND BAFFLES WEEKLY & AFTER EACH RAINFALL EVENT. REMOVE SEDIMENT FROM TRAP & BAFFLES AND RESTORE TO ORIGINAL VOLUME WHEN
- SEDIMENT ACCUMULATES TO ABOUT ½ THE DESIGN VOLUME. REPAIR / REPLACE BAFFLES IF TORN, COLLAPSED, OR INEFFECTIVE ITCHES WILL BE CLEANED OUT IMMEDIATELY TO REMOVE SEDIMENT OR OBSTRUCTIONS FROM THE FLOW AREA. THE DIVERSION RIDGES WILL ALSO BE
- SPACING WILL BE 8 FEET MAX WHEN STANDARD STRENGTH FABRIC AND WIRE BACKING ARE USED. IF ROCK FILTERS ARE DESIGNED AT LOW POINTS IN THE IN THE SEDIMENT FENCE THE ROCK WILL BE REPAIRED OR REPLACED IF IT BECOMES HALF FULL OF SEDIMENT, NO LONGER DRAINS AS DESIGNED OR IS DAMAGED.



STANDARD SIDEWALK DETAIL FOR COMMERCIAL AREAS SD 8-15

NOT TO SCALE

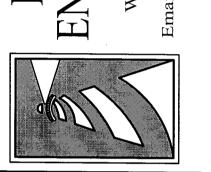


TYPICAL X-SECTION AT PARKING AREA

VICINITY MAP (NOT TO SCALE):

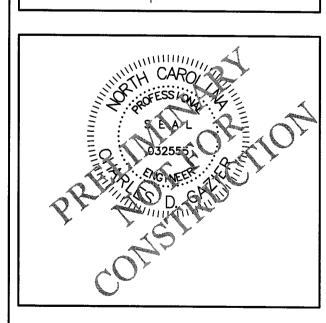
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**CLIENT INFORMATION:** 

RITZ DEVELOPMENT 6 LLC 1319-CC MILITARY CUTOFF RD SUITE 172 MR. MATT SCHARF (910)538-9901

CDC | SHEET SIZE: DRAWN: CDC DATE: HECKED 06/04/2014 APPROVED: CDC | SCALE: NTS PROJECT NUMBER: 2014-009

DRAWING NUMBER: